


- PLAN NOTES:**
- FOR GENERAL NOTES, SYMBOL LIST, ABBREVIATIONS AND FIRE ALARM SYSTEM DRAWING LIST REFER TO DWG FA001.00.
 - FOR EXACT LOCATION AND QUANTITIES OF MECHANICAL AND PLUMBING EQUIPMENT AND DEVICES REFER TO MECHANICAL AND PLUMBING DWGS.
 - ALL CONDUIT PENETRATIONS THROUGH FIRE RATED PARTITIONS ARE TO BE PROVIDED WITH FIRE STOP SEALS AS REQUIRED BY CODE TO MAINTAIN FIRE RATING OF PARTITIONS.
 - UNLESS OTHERWISE NOTED ON DRAWING MOUNTING HEIGHTS OUTLETS AND EQUIPMENT SHALL BE AS INDICATED ON SYMBOL LIST & SPECIFICATIONS.
 - CENTERLINE ELEVATION FOR ALL SPEAKER AND/OR STROBE UNITS TO BE LOCATED 8'-0" ABOVE FLOOR OR 6" BELOW THE CEILING.
 - CENTERLINE ELEVATION FOR ALL PULL STATIONS IS 48" ABOVE FLOOR.
 - ACCESS SHALL BE PROVIDED TO EACH DETECTOR FOR PERIODIC INSPECTION, MAINTENANCE AND TESTING AS PER SECTION 907.12 OF N.Y.C. BUILDING CODE.
 - UPON REMOVAL OF ANY EXISTING EQUIPMENT AND DEVICES, CONTRACTOR SHALL REPAIR (PLASTER/TILE/PAINT) THE WALL TO MATCH EXISTING.
 - THE ELECTRICAL CONTRACTOR SHALL BE RESPONSIBLE FOR COORDINATING THE WORK WITH THE FIRE EXTINGUISHING CONTRACTOR.
 - THE MICRO SWITCH CONTACT SHALL BE RESET AFTER FIRE EXTINGUISHING SYSTEM OPERATION TO ENABLE TO TURN ON THE POWER TO THE EQUIPMENT UNDER THE HOOD.
 - MICRO SWITCH CONTACT FOR FIRE ALARM SYSTEM INTERFACE UPON THE ACTIVATION OF THE KITCHEN FIRE EXTINGUISHING SYSTEM (ANSUL SYSTEM) SHALL BE ANNUNCIATE AT THE FIRE ALARM CONTROL PANEL.
 - CONTRACTOR SHALL UTILIZE EXISTING CIRCUITS SERVING THE EXISTING MOTOR STARTER AUD. BLOWER. REUTILIZE EXISTING CONDUITS (EXTEND CONDUIT AND WIRING AS NECESSARY) TO THE NEW LOCATION.

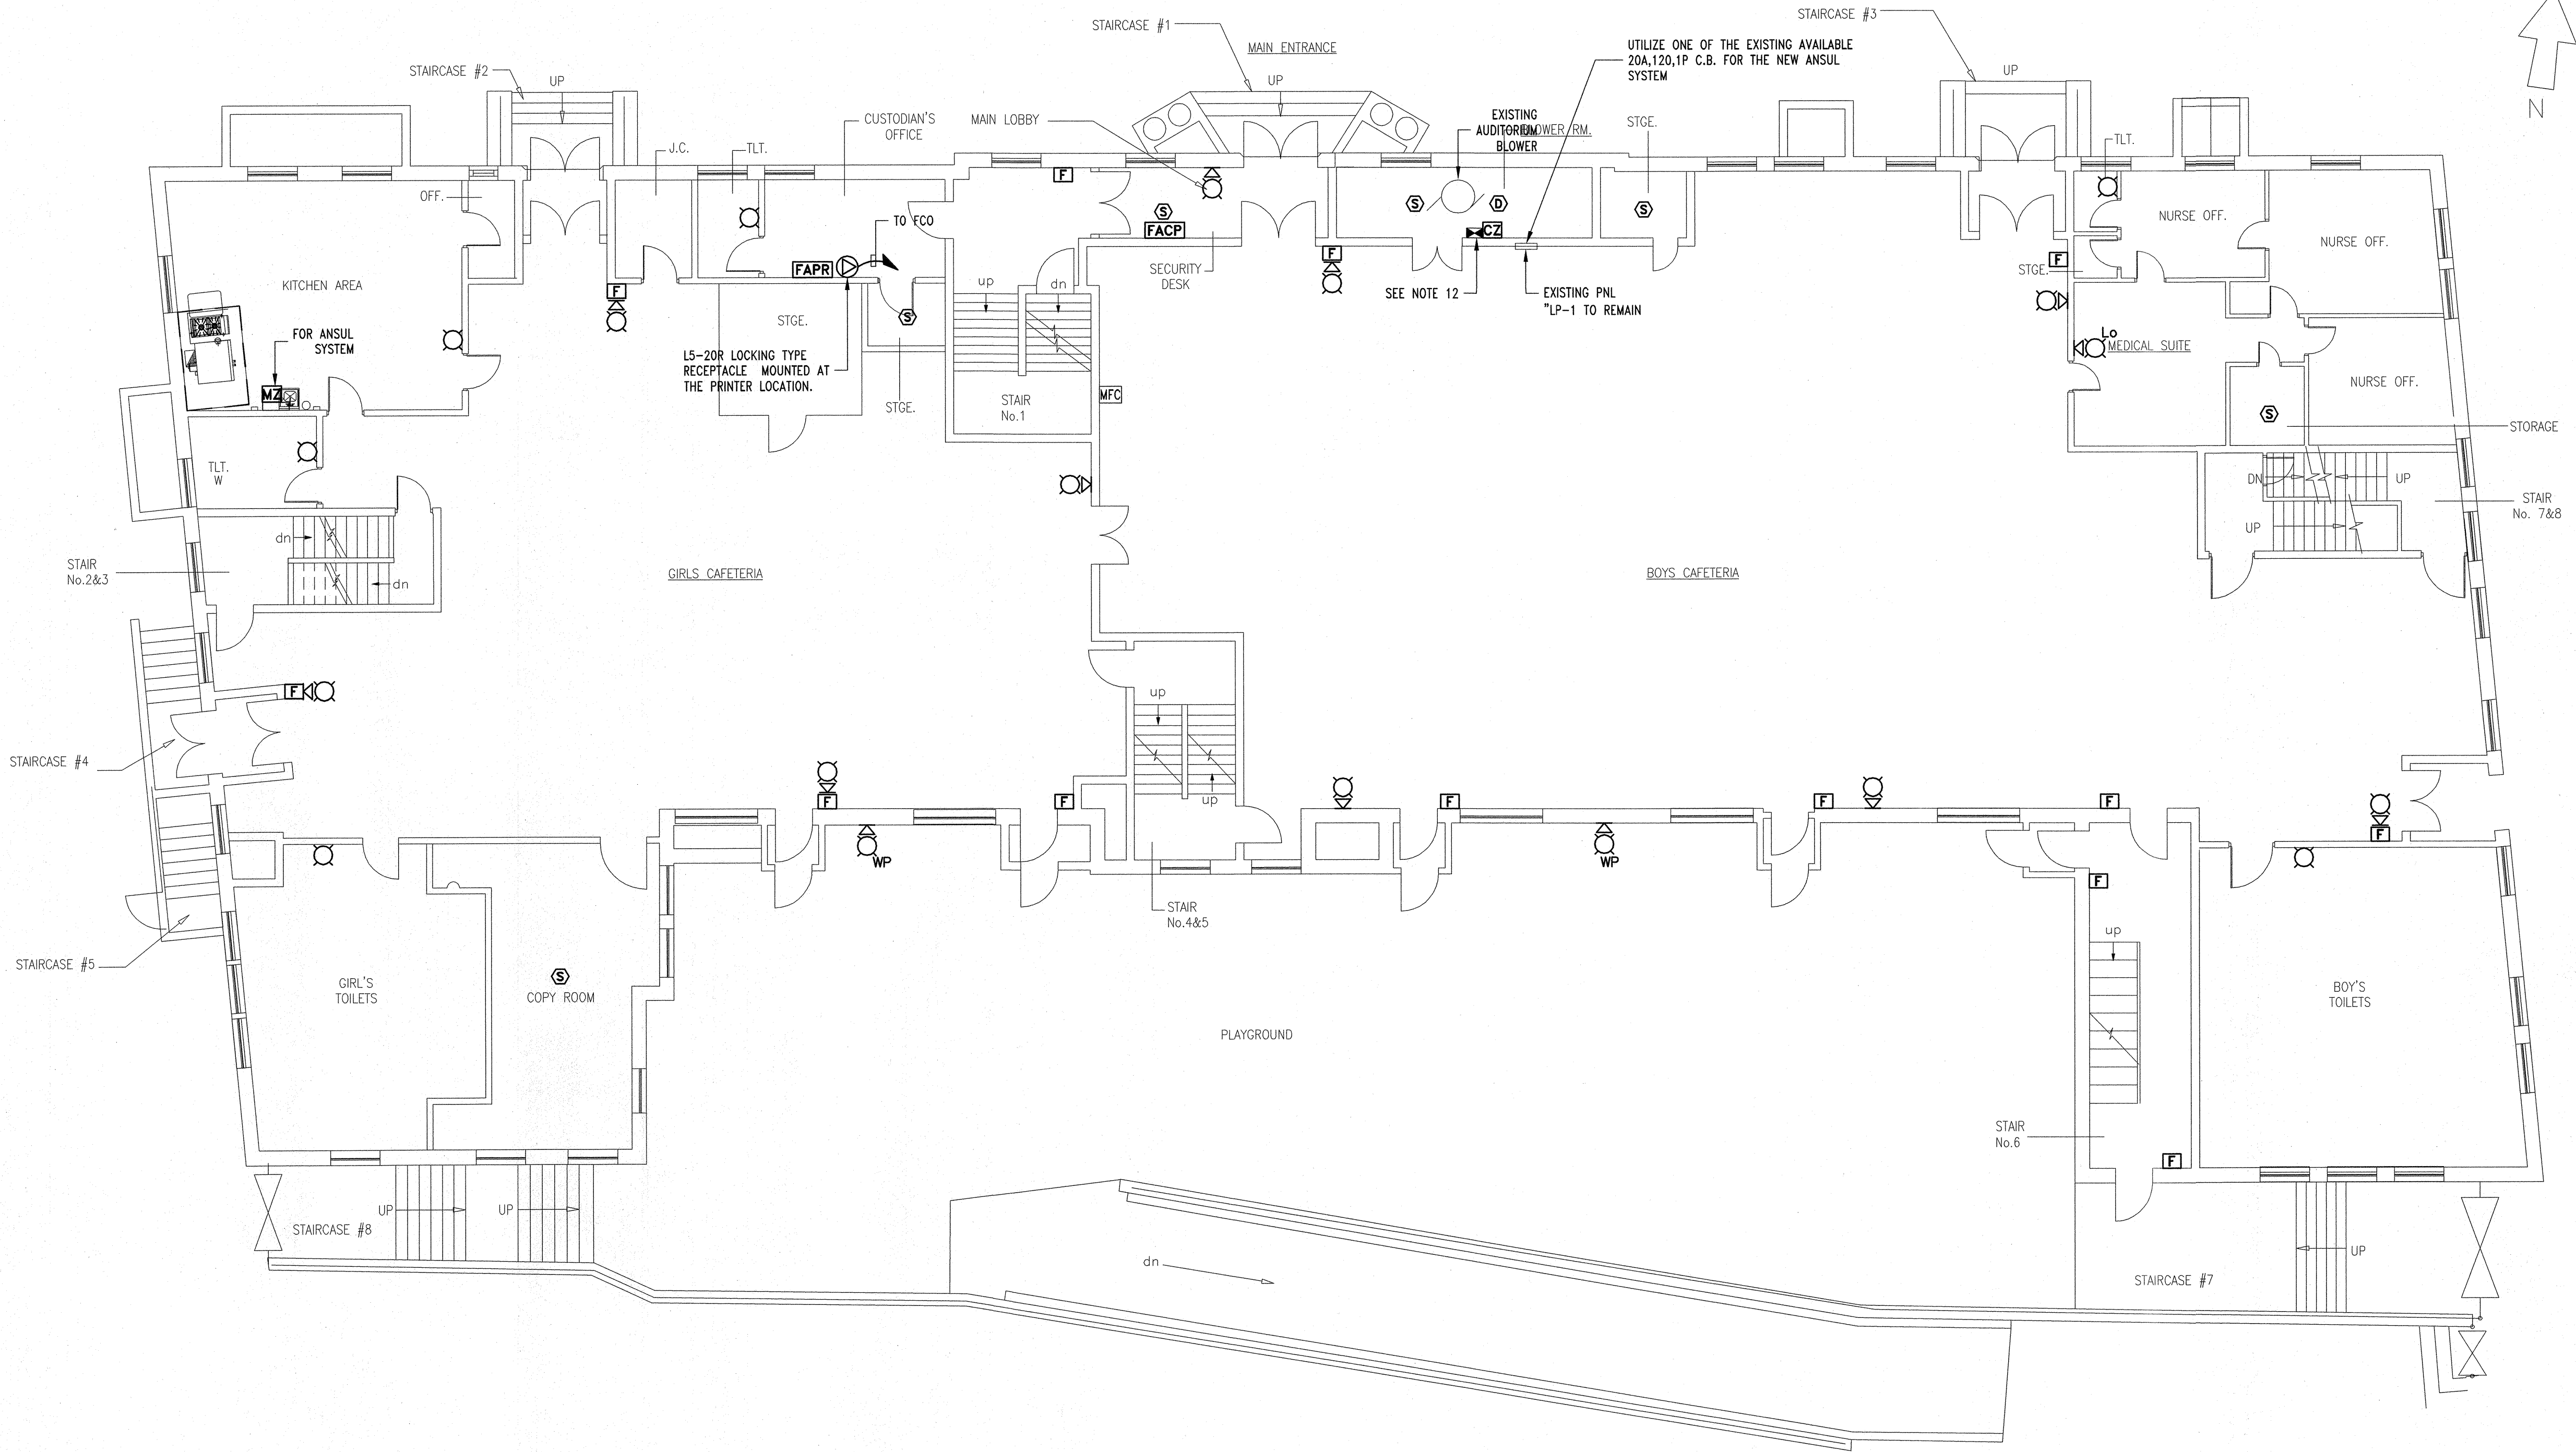

FIRST FLOOR PLAN
SCALE: 1/8" = 1'-0"

President & CEO
Lorraine Grillo

Board of Trustees
Chancellor Dennis M. Walcott, Chairman
Curtis A. Harris
Emily A. Youssouf

Architecture & Engineering

E. Bruce Barrett, R.A. LEED A.P., Vice President
Elan R. Abneri, P.E., Director, Design Consultant Management
Stanley Dahir, R.A., Director, Quality Control & Construction Support
Maria A. Gomez, P.E., LEED A.P., Director, A&E In-House Design
George D. Roussey, P.E., LEED A.P., Director, Technical Standards
Stacey Spann-Thorn, Director, Operations Support

Consultants:

CONSULTING ENGINEERS, INC.
MECHANICAL, ELECTRICAL, PLUMBING
& FIRE PROTECTION

375 MAIN STREET
HACKENSACK, N.J. 07601


TEL (201) 678 2224
FAX (201) 678 1860

NOTE: Drawing may be printed at reduced scale

IT IS A VIOLATION OF THE STATE EDUCATION LAW SECTION 7209 (2) FOR ANY PERSON TO ALTER AN ITEM IN ANY WAY UNLESS SUCH PERSON IS ACTING UNDER THE DIRECTION OF A LICENSED PROFESSIONAL ENGINEER, AND THE ENGINEER STAMPS SUCH CHANGES

06/05/15 ISSUE FOR BID

| No. | Date | Revision |
|-----|------|----------|
| | | |
| | | |
| | | |

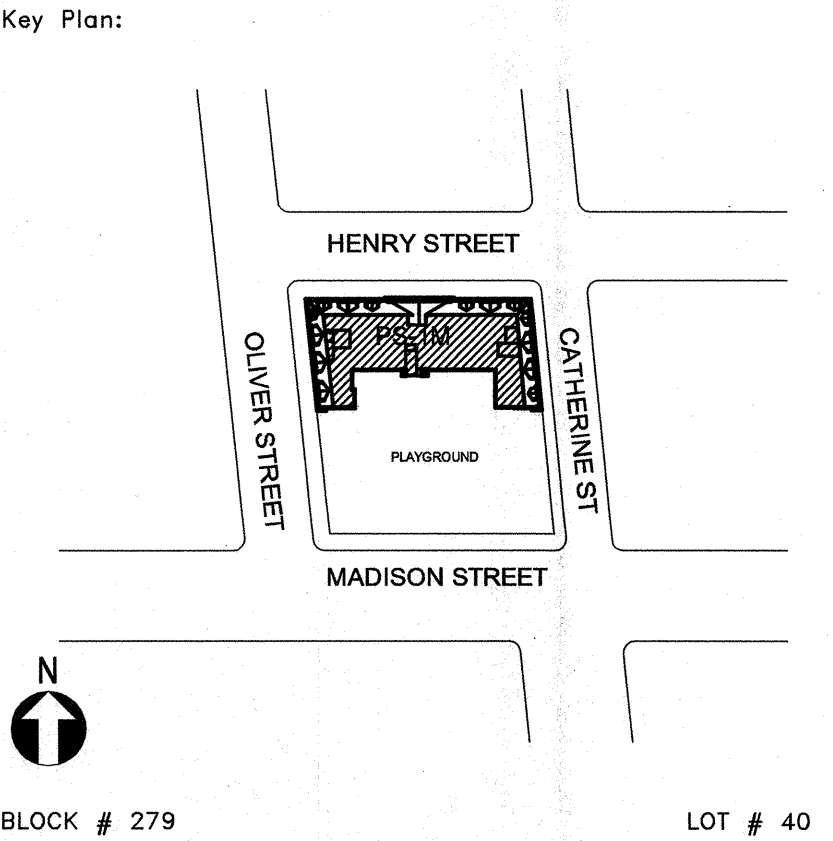

| | | |
|-----------------------------|------------------------|---------------------|
| SCA Design Manager: | R. GOIK | |
| Project Architect/Engineer: | H. MENA, P.E. | |
| Discipline Lead: | H. MENA, P.E. | |
| Designer: | C. LARA | |
| Drawn by: | C. LARA | |
| Checked by: | H. MENA, P.E. | |
| Design No. : D015391 | Facility Code: M001 | Date: 06/05/2015 |

Project:
**PS 001 MANHATTAN
FIRE ALARM SYSTEM
UPGRADE.**

Address:
8 HENRY STREET
MANHATTAN, NY 10038

Drawing Title:
**FIRE ALARM SYSTEM FIRST FLOOR
PLAN**

| | |
|-------------------------|-----------------|
| Drawing No.: | FA102.00 |
| Sheets in Contract Set: | 49 of 57 |
| Sheets in DOB Set: | of |